



TRANSPORTATION CABINET

Frankfort, Kentucky 40622
www.transportation.ky.gov/

Steven L. Beshear
Governor

Michael W. Hancock, P.E.
Secretary

November 14, 2012

CALL NO. 118
CONTRACT ID NO. 121370
ADDENDUM # 1

Subject: Fayette County, STP 3003 (277)
Letting November 16, 2012

- (1) Revised - Plan Sheets - R2b & R3
- (2) Revised - Bid Items - Pages 98-99 of 99

Proposal revisions are available at <http://transportation.ky.gov/Construction-Procurement/>.

Plan revisions are available at <http://www.lynnimaging.com/kytransportation/>.

If you have any questions, please contact us at 502-564-3500.

Sincerely,

A handwritten signature in blue ink that reads "Ryan Griffith".

Ryan Griffith
Director
Division of Construction Procurement

RG:ks
Enclosures



An Equal Opportunity Employer M/F/D

GENERAL SUMMARY

COUNTY OF	ITEM NO.	SHEET NO.
FAYETTE	7-593.12	R2B

ITEM	DESCRIPTION	UNIT	TOTAL PROJECT
71	CRUSHED AGGREGATE SIZE NO. 57 ①	TON	200
78	CRUSHED AGGREGATE SIZE NO. 2 ①	TON	200
1310	REMOVE PIPE	LIN FT	24
1314	PLUG PIPE	EACH	2
1810	STANDARD CURB AND GUTTER	LIN FT	4,172
2159	TEMPORARY DITCH	LIN FT	2,345
2160	CLEAN TEMPORARY DITCH	LIN FT	7,035
2230	EMBANKMENT IN PLACE ②	CU YD	56,763
2240	REMOVE UNDERGROUND TANK - SEPTIC	EACH	2
2267	REMOVE AND REST FENCE- 6' CHAIN LINK	LIN FT	340
2274	FENCE - 6' CHAIN LINK (INCLUDES 2 GATES)	LIN FT	960
2545	CLEARING AND GRUBBING ③	LP SUM	1
2562	SIGNS (PERMANENT)	SO FT	98.25
2568	MOBILIZATION	LP SUM	1
2569	DEMOBILIZATION	LP SUM	1
2585	EDGE KEY	LIN FT	27
2598	GEOTEXTILE FABRIC TYPE III ①	SO YD	100
2600	GEOTEXTILE FABRIC TYPE IV - FOR PIPE	SO YD	5,200
2625	REMOVE HEADWALL	EACH	2
2650	MAINTAIN AND CONTROL TRAFFIC	LP SUM	1
2701	TEMPORARY SILT FENCE	LIN FT	2,345
2703	SILT TRAP TYPE A ④	EACH	16
2704	SILT TRAP TYPE B	EACH	16
2705	SILT TRAP TYPE C	EACH	24
2706	CLEAN SILT TRAP TYPE A	EACH	48
2707	CLEAN SILT TRAP TYPE B	EACH	48
2708	CLEAN SILT TRAP TYPE C	EACH	72
2709	CLEAN TEMPORARY SILT FENCE	LIN FT	7,035
2726	STAKING	LP SUM	1
3479	TIE IN ⑤	EACH	1
5950	EROSION CONTROL BLANKET ⑥	SO YD	7,850
5952	TEMPORARY MULCH	SO YD	38,139
5953	TEMPORARY SEEDING AND PROTECTION	SO YD	30,202
5966	TOPDRESSING FERTILIZER	TON	1.6
5985	SEEDING AND PROTECTION	SO YD	30,202
6514	PAVE STRIPING PERM PAINT-4" WHITE	LIN FT	813
6514	PAVE STRIPING PERM PAINT-4" YELLOW	LIN FT	2,412
6568	PAVE MARKING-THERMO STOP BAR-24 IN	LIN FT	69
2313IER70I	PIPELINE VIDEO INSPECTION	LIN FT	1,059
24095EC	TEMPORARY CONSTRUCTION ENTRANCE ⑦	EACH	2
10020NS	FUEL ADJUSTMENT	DOLLAR	24,945.00
10030NS	ASPHALT ADJUSTMENT	DOLLAR	13,340.00
1799	SANITARY MANHOLE - 4 FT DIAMETER	EACH	13
1799	SANITARY MANHOLE - 5 FT DIAMETER	EACH	4
1799	SANITARY MANHOLE WITH EXTERNAL DROP - 4 FT DIAMETER	EACH	2
3387	8" SANITARY SEWER PIPE - (PVC-SDR 35)	LIN FT	954
24564EN	PVC PIPE - SANITARY SEWER LATERALS - (PVC-SDR 35) (24 TOTAL)	LIN FT	417
24564EN	PVC PIPE - 18" SANITARY SEWER PIPE - (PVC-SDR 26, HEAVY WALL)	LIN FT	832
24564EN	PVC PIPE - 27" SANITARY SEWER PIPE - (PVC-SDR 26, HEAVY WALL)	LIN FT	765
2690	SAFELoading ⑧	CU YD	56
22978EN	ROADWAY EXCAVATION - SPECIAL ⑨	CU YD	12,745

NOTES:

- ① TO BE USED AS DIRECTED BY THE KYTC CONSTRUCTION INSPECTOR
- ② SEE NOTE ON THE FIRST CROSS SECTION SHEET FOR BASIS OF EARTHWORK QUANTITIES.
- ③ APPROXIMATELY 7.9 ACRES. SEE "CLEARING AND GRUBBING" NOTE ON THE ROADWAY PLAN SHEET FOR ADDITIONAL BID ITEM DESCRIPTION
- ④ SHALL BE ALTERNATE NO. 2
- ⑤ TIE STORM SEWER TO EXISTING RCBC
- ⑥ TO BE USED ON 2:1 SLOPES AND AS DIRECTED BY THE KYTC CONSTRUCTION INSPECTOR
- ⑦ SEE THE DETAIL ON THE EROSION CONTROL PLAN
- ⑧ SEE THE NOTE ON THE SANITARY SEWER PLAN SHEET FOR ITEM DESCRIPTION
- ⑨ SEE "ROADWAY EXCAVATION - SPECIAL" NOTE ON THE ROADWAY PLAN SHEET FOR ADDITIONAL BID ITEM DESCRIPTION AND BASIS OF QUANTITY.

TOTAL PROJECT EARTHWORK ②	
COMMON EXCAVATION	EMBANKMENT IN PLACE
10,557 CU. YD. EXCAVATION	56,763 CU. YD. EMBANKMENT

FILE NAME: C:\PWORK\ALEX.SMITH\0044517\KYTC_SHEET1.CEL

USER: alex.smith
DATE PLOTTED: April 1, 2010



E-SHEET NAME:

MicroStation v8.11.7.180

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 REVISED 11-13-2012

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22978EN	ROADWAY EXCAVATION - SPECIAL ⑨ 	CU YD	12,745

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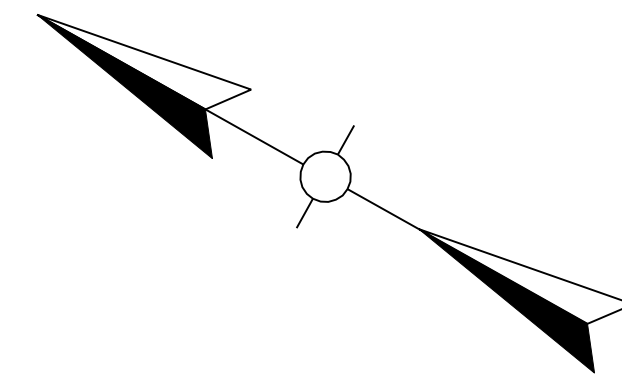
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FILE NAME: C:\PWORK\ALEX.SMITH\0144517\KYTC_SHEET1.CEL

USER: alex.smith
DATE PLOTTED: April 1, 2010

E-SHEET NAME:

MicroStation v8.11.7.180



CLEARING AND GRUBBING

CLEAR AND GRUB THE ENTIRE AREA INSIDE THE "CONSTRUCTION LIMITS." DO NOT DISTURB THE EXISTING RCBCs, THE SANITARY SEWER SYSTEM, ACTIVE STORM SEWER SYSTEM OR ANY ACTIVE UTILITY. ITEMS TO BE CLEARED AND GRUBBED INCLUDE BUT ARE NOT LIMITED TO: VEGETATION, TREES, CONCRETE PADS, ASPHALT, CURB AND GUTTER, FENCES, POSTS, STRUCTURES, ABANDONED UTILITY STRUCTURES, DRAINAGE PIPES, DRAINAGE STRUCTURES AND SIDEWALKS. DO NOT CLEAR AND GRUB THE ENTRANCE INTO THE TEMPORARY HOUSING UNTIL IT IS NECESSARY TO CONSTRUCT THE DIVERSION AND NEW ENTRANCE.

ROADWAY EXCAVATION - SPECIAL

12,745 CUBIC YARDS OF "ROADWAY EXCAVATION - SPECIAL" REMOVE THE TOP 12" OF MATERIAL (INCLUDING SOILS AND PAVEMENTS) FROM INSIDE THE ENTIRE CONSTRUCTION LIMITS, AND HAUL OFF TO A PERMITTED SOLID WASTE DISPOSAL FACILITY. THE UNIT PRICE FOR THIS BID ITEM INCLUDES REMOVAL, HAULING AND DISPOSAL OF THIS MATERIAL. NO ADDITIONAL DIRECT COMPENSATION WILL BE PAID IN ASSOCIATION WITH THIS BID ITEM.

CONTRACTOR SHALL USE EXTREME CAUTION WHEN WORKING IN THE VICINITY OF THE EXISTING RCBCs AND SANITARY SEWER.

NOTES:
 PROPOSED STORM SEWER AND SANITARY SEWER PIPES ARE NOT SHOWN ON THE ROADWAY PLAN. SEE THE GRADE AND DRAIN PLAN FOR PROPOSED PIPES.

CONSTRUCT *TEMPORARY CONSTRUCTION ENTRANCE* - 2 EACH, AT LOCATIONS APPROVED BY THE KYTC CONSTRUCTION INSPECTOR. SEE DETAIL ON THE EROSION CONTROL PLAN.

44' LT STA 11+60.4 TO 154' RT STA 12+48.2 CONST 250 LF OF 6' CHAIN LINK FENCE, AS SHOWN. CONSTRUCT GATE ACROSS EXISTING DEROODE STREET FOR CONSTRUCTION ACCESS

STA 12+02.14 CONST 27 LF EDGE KEY

LT STA 12+02.14 SAW CUT EXIST CURB & GUTTER (INCIDENTAL TO CLEARING AND GRUBBING)

LT STA 12+02 TO 20+00 DEROODE STREET, CONST 756 LF STANDARD CURB AND GUTTER

DEROODE ST CURVE DATA

PI STA 12+96.73
 $\Delta = 35^{\circ}01'22"$ LT
 $T = 109.88'$
 $L = 150.82'$
 $R = 150.00'$
 $E = 2.05'$
 $\theta = N/A$
 Runoff=SEE CROSS SECTIONS
 Runout=SEE CROSS SECTIONS

DEROODE ST CURVE DATA

PI STA 14+15.04
 $\Delta = 20^{\circ}07'44"$ RT
 $T = 44.37'$
 $L = 87.83'$
 $R = 250.00'$
 $E = 3.91'$
 $\theta = N/A$
 Runoff=SEE CROSS SECTIONS
 Runout=SEE CROSS SECTIONS

ALLEY CURVE DATA

PI STA 41+24.94
 $\Delta = 86^{\circ}06'18"$ LT
 $T = 32.70'$
 $L = 52.60'$
 $R = 35.00'$
 $E = 12.90'$
 $\theta = N/A$
 Runoff=N/A
 Runout=N/A

RT STA 12+02.14 SAW CUT EXIST CURB & GUTTER (INCIDENTAL TO CLEARING AND GRUBBING)

RT STA 12+04.4 TO 13+49 DEROODE STREET, CONST 154 LF STANDARD CURB AND GUTTER

RT STA 14+23 TO 16+91 DEROODE STREET, CONST 234 LF STANDARD CURB AND GUTTER

RT STA 17+66 TO 20+00 DEROODE STREET, CONST 212 LF STANDARD CURB AND GUTTER

RT STA 40+25 TO 47+18 ALLEY, CONST 693 LF STANDARD CURB AND GUTTER


LT STA 40+06 TO 44+22 ALLEY, CONST 416 LF STANDARD CURB AND GUTTER

LT STA 44+68 TO 47+18 ALLEY, CONST 250 LF STANDARD CURB AND GUTTER

RT STA 50+12 TO 51+48 ALLEY CONNECTOR, CONST 145 LF STANDARD CURB AND GUTTER

LT STA 50+12 TO 51+51 ALLEY CONNECTOR, CONST 147 LF STANDARD CURB AND GUTTER

86' LT STA 17+41 PLUG THE EXISTING STORM SEWER. PIPE WILL BE REMOVED WITH CLEARING AND GRUBBING

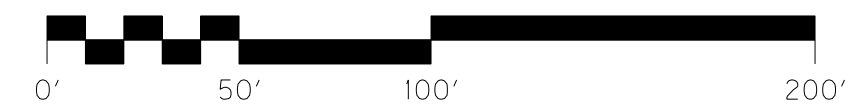

SCALE: 1"=50'

SOUTHEND PARK REDEVELOPMENT
 ROADWAY PLAN
 STA. 12+02.14 TO STA. 20+00.00

FILE NAME: C:\PWORK\MSP\001451\KYTC_SHEET.CEL


USER: alexi.smith
 DATE PLOTTED: October 11, 2010

E-SHEET NAME:

MicroStation v8.11.7.443

MATCHLINE STA 20+00

REVISION 11-13-2012

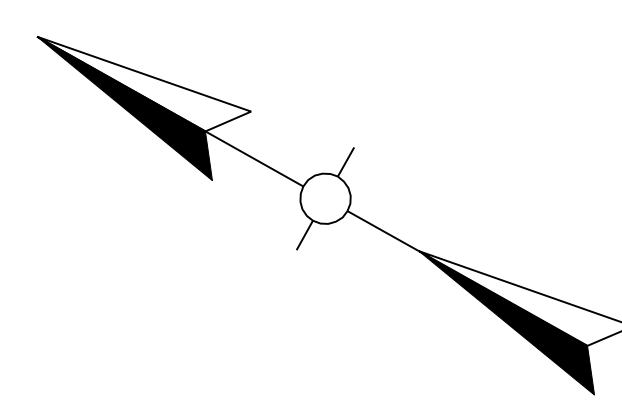

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RT STA 17+66 TO 20+00 DEROODE STREET, CONST 212 LF STANDARD CURB AND GUTTER

RT STA 40+25 TO 47+18 ALLEY, CONST 693 LF STANDARD CURB AND GUTTER

DEROODE ST CURVE DATA

PI STA 14+15.04
 $\Delta = 20^{\circ}07'44"$ RT
 T=44.37'
 L=87.83'
 R=250.00'
 E=3.91'
 S=SEE CROSS SECTIONS
 Runoff=SEE CROSS SECTIONS
 Runout=SEE CROSS SECTIONS

LT STA 40+06 TO 44+22 ALLEY, CONST 146 LF STANDARD CURB AND GUTTER

LT STA 44+68 TO 47+18 ALLEY, CONST 250 LF STANDARD CURB AND GUTTER



ALLEY CURVE DATA

PI STA 41+24.94
 $\Delta = 86^{\circ}06'18"$ LT
 T=32.70'
 L=52.60'
 R=35.00'
 E=12.90'
 S=N/A
 Runoff=N/A
 Runout=N/A

RT STA 50+12 TO 51+48 ALLEY CONNECTOR, CONST 145 LF STANDARD CURB AND GUTTER

LT STA 50+12 TO 51+51 ALLEY CONNECTOR, CONST 147 LF STANDARD CURB AND GUTTER

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FILE NAME: C:\PWORK\MSP\00144517\KYTC_SHEET.CEL

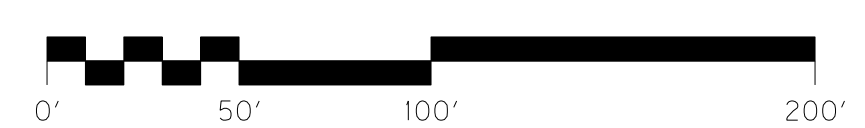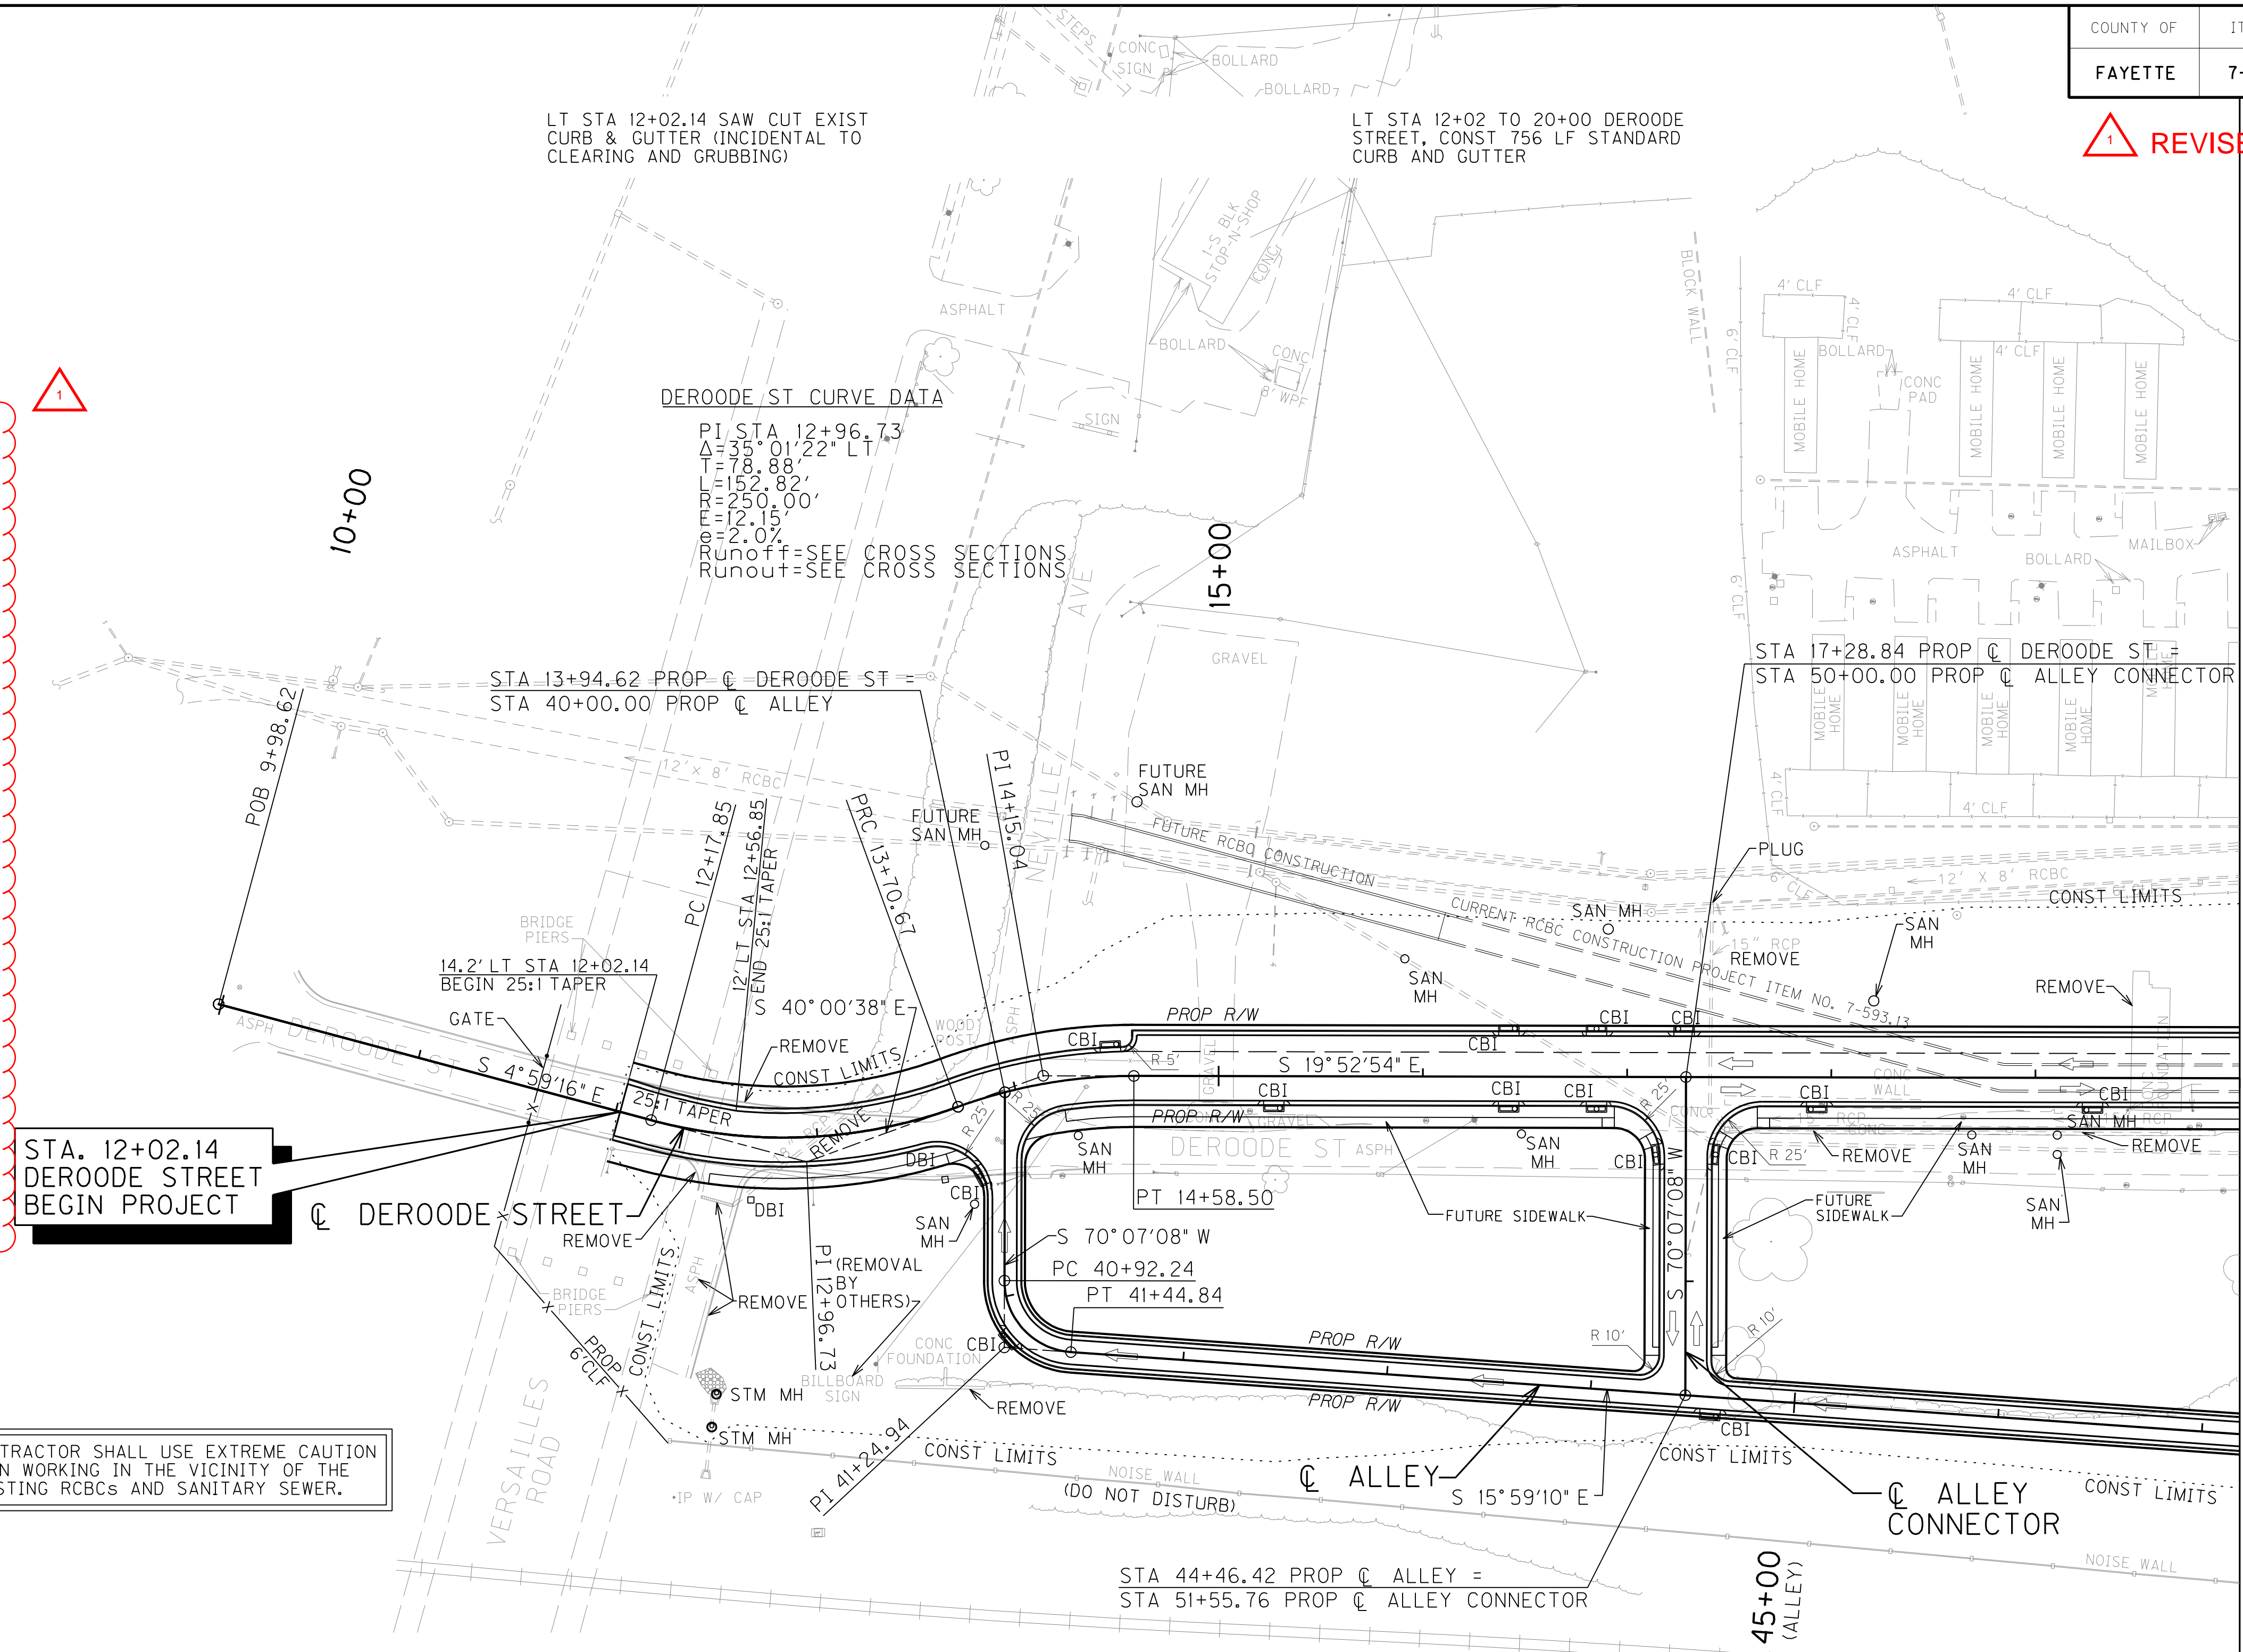USER: alexi.smith
 DATE PLOTTED: October 11, 2010

E-SHEET NAME:

MicroStation v8.11.7.443

PROPOSAL BID ITEMS

Report Date 11/13/12

Section: 0001 - PAVING

LINE	BID CODE	ALT	DESCRIPTION	QUANTITY	UNIT	UNIT PRICE	FP	AMOUNT
0010	00001		DGA BASE	3,624.00	TON		\$	
0020	00212		CL2 ASPH BASE 1.00D PG64-22	2,960.00	TON		\$	
0030	00301		CL2 ASPH SURF 0.38D PG64-22	452.00	TON		\$	

Section: 0002 - ROADWAY

LINE	BID CODE	ALT	DESCRIPTION	QUANTITY	UNIT	UNIT PRICE	FP	AMOUNT
0040	00071		CRUSHED AGGREGATE SIZE NO 57	200.00	TON		\$	
0050	00078		CRUSHED AGGREGATE SIZE NO 2	200.00	TON		\$	
0060	01310		REMOVE PIPE	24.00	LF		\$	
0070	01314		PLUG PIPE	2.00	EACH		\$	
0080	01799		SANITARY SEWER MANHOLE(WITH EXTERNAL DROP - 4 FOOT)	2.00	EACH		\$	
0090	01799		SANITARY SEWER MANHOLE(5 FOOT)	4.00	EACH		\$	
0100	01799		SANITARY SEWER MANHOLE(4 FOOT)	13.00	EACH		\$	
0110	01810		STANDARD CURB AND GUTTER	4,172.00	LF		\$	
0120	02159		TEMP DITCH	2,345.00	LF		\$	
0130	02160		CLEAN TEMP DITCH	7,035.00	LF		\$	
0140	02230		EMBANKMENT IN PLACE	56,763.00	CUYD		\$	
0150	02240		REMOVE UNDERGROUND TANK	2.00	EACH		\$	
0160	02267		REMOVE & RESET FENCE	340.00	LF		\$	
0170	02274		FENCE-6 FT CHAIN LINK	960.00	LF		\$	
0180	02545		CLEARING AND GRUBBING(7.9 ACRES)	1.00	LS		\$	
0190	02562		SIGNS	98.25	SQFT		\$	
0200	02585		EDGE KEY	27.00	LF		\$	
0210	02598		FABRIC-GEOTEXTILE TYPE III	100.00	SQYD		\$	
0220	02600		FABRIC GEOTEXTILE TY IV FOR PIPE	5,200.00	SQYD	\$2.00	\$	\$10,400.00
0230	02625		REMOVE HEADWALL	2.00	EACH		\$	
0240	02650		MAINTAIN & CONTROL TRAFFIC	1.00	LS		\$	
0250	02690		SAFELOADING	56.00	CUYD		\$	
0260	02701		TEMP SILT FENCE	2,345.00	LF		\$	
0270	02703		SILT TRAP TYPE A	16.00	EACH		\$	
0280	02704		SILT TRAP TYPE B	16.00	EACH		\$	
0290	02705		SILT TRAP TYPE C	24.00	EACH		\$	
0300	02706		CLEAN SILT TRAP TYPE A	48.00	EACH		\$	
0310	02707		CLEAN SILT TRAP TYPE B	48.00	EACH		\$	
0320	02708		CLEAN SILT TRAP TYPE C	72.00	EACH		\$	
0330	02709		CLEAN TEMP SILT FENCE	7,035.00	LF		\$	
0340	02726		STAKING	1.00	LS		\$	
0350	03387		PVC PIPE-8 IN	954.00	LF		\$	
0360	03479		TIE-IN	1.00	EACH		\$	
0370	05950		EROSION CONTROL BLANKET	7,850.00	SQYD		\$	
0380	05952		TEMP MULCH	38,139.00	SQYD		\$	
0390	05953		TEMP SEEDING AND PROTECTION	30,202.00	SQYD		\$	
0400	05966		TOPDRESSING FERTILIZER	1.60	TON		\$	
0410	05985		SEEDING AND PROTECTION	30,202.00	SQYD		\$	
0420	06514		PAVE STRIPING-PERM PAINT-4 IN(WHITE)	813.00	LF		\$	

PROPOSAL BID ITEMS

Report Date 11/13/12

LINE	BID CODE	ALT	DESCRIPTION	QUANTITY	UNIT	UNIT PRICE	FP	AMOUNT
0430	06514		PAVE STRIPING-PERM PAINT-4 IN(YELLOW)	2,412.00	LF		\$	
0440	06568		PAVE MARKING-THERMO STOP BAR-24IN	69.00	LF		\$	
0450	10020NS		FUEL ADJUSTMENT	24,945.00	DOLL	\$1.00	\$	\$24,945.00
0460	10030NS		ASPHALT ADJUSTMENT	13,340.00	DOLL	\$1.00	\$	\$13,340.00
0470	22978EN		ROADWAY EXCAVATION-SPECIAL(ADDED: 11-13-12)	12,745.00	CUYD		\$	
0480	23131ER701		PIPELINE VIDEO INSPECTION	1,059.00	LF		\$	
0490	24095EC		TEMPORARY CONSTRUCTION ENTRANCE	2.00	EACH		\$	
0500	24564EN		PVC PIPE(27 INCH SANITARY SEWER-PVC SDR 26, HEAVY WALL)	765.00	LF		\$	
0510	24564EN		PVC PIPE(18 INCH SANITARY SEWER PIPE- PVC-SDR26, HEAVY WALL)	832.00	LF		\$	
0520	24564EN		PVC PIPE(SANITARY SEWER LATERALS- PVC-SDR 35)	417.00	LF		\$	

Section: 0003 - DRAINAGE

LINE	BID CODE	ALT	DESCRIPTION	QUANTITY	UNIT	UNIT PRICE	FP	AMOUNT
0530	00439		ENTRANCE PIPE-12 IN	60.00	LF		\$	
0540	00522		STORM SEWER PIPE-18 IN	1,323.00	LF		\$	
0550	00524		STORM SEWER PIPE-24 IN	697.00	LF		\$	
0560	00556		STORM SEWER PIPE-30 IN EQUIV	98.00	LF		\$	
0570	01456		CURB BOX INLET TYPE A	21.00	EACH		\$	
0580	01496		DROP BOX INLET TYPE 3	5.00	EACH		\$	
0590	01756		MANHOLE TYPE A	4.00	EACH		\$	

Section: 0004 - MOBILIZATION / DEMOBILIZATION

LINE	BID CODE	ALT	DESCRIPTION	QUANTITY	UNIT	UNIT PRICE	FP	AMOUNT
0600	02568		MOBILIZATION	1.00	LS		\$	
0610	02569		DEMOBILIZATION	1.00	LS		\$	